TOWN HOUSE DEVELOPMENT

26 LITHGOW STREET, GOULBURN, NSW

DA01.1 TITLE SHEET

DA02.1 SITE ANALYSIS PLAN **DEMOLITION PLAN**

DA03.1 DA04.1 SITE PLAN

LANDSCAPE PLAN DA05.1

DA06.1 **GROUND FLOOR PLAN**

DA07.1 **ELEVATIONS** SECTIONS DA11.1


DA12.1 ISO VIEWS

ISO VIEWS DA13.1

DA16.1 **ROOF PLAN**

AREA PLANS DA17.1 SEDIMENT & EROSION CONTROL PLAN DA19.1



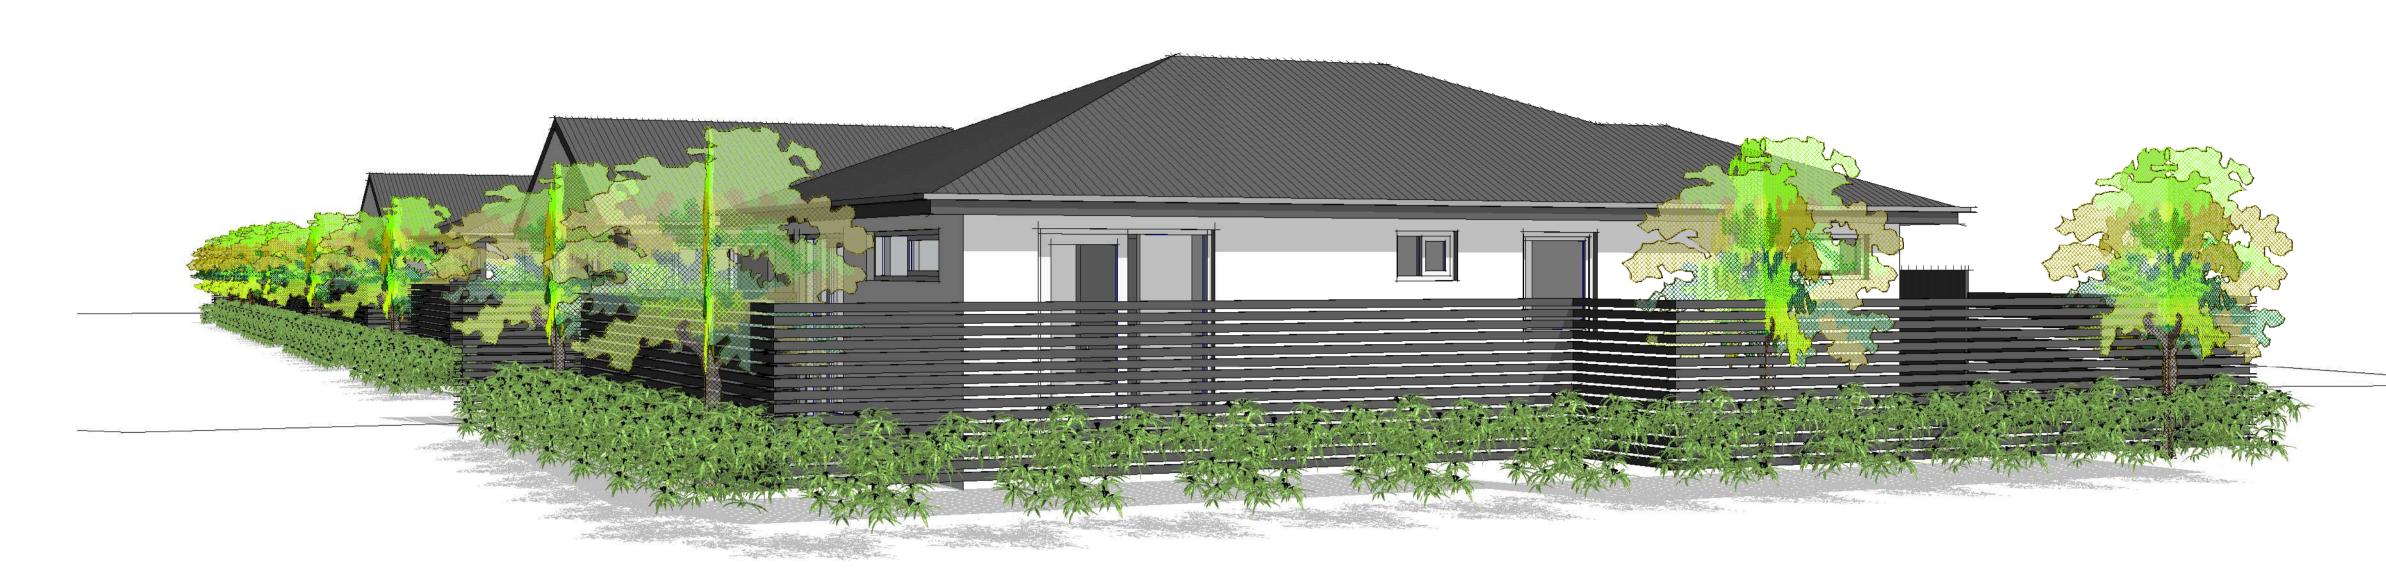





MULTI UNIT DEVELOPMENT PROJECT:

DEVELOPMENT APPLICATION ISSUE:

DRAWING TITLE:

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DATE: SEPT. '24 DRAWN: HG PR. NO: LITHGOW ST DWG NO: **DA01.1**



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Assessor name Jamie Bonnefin

Accreditation No. 10056

Property Address 26 Lithgow
Street, GOULBURN
NSW,2580

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SITE ANALYSIS PLAN

1: 250

PROJECT: MULTI UNIT DEVELOPMENT

ISSUE: DEVELOPMENT APPLICATION

DRAWING
TITLE: SITE ANALYSIS PLAN

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PROJECT

ADDRESS:

26 LITHGOW STREET, GOULBURN, NSW

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PR. NO: LITHGOW ST

DWG NO: DA02.1

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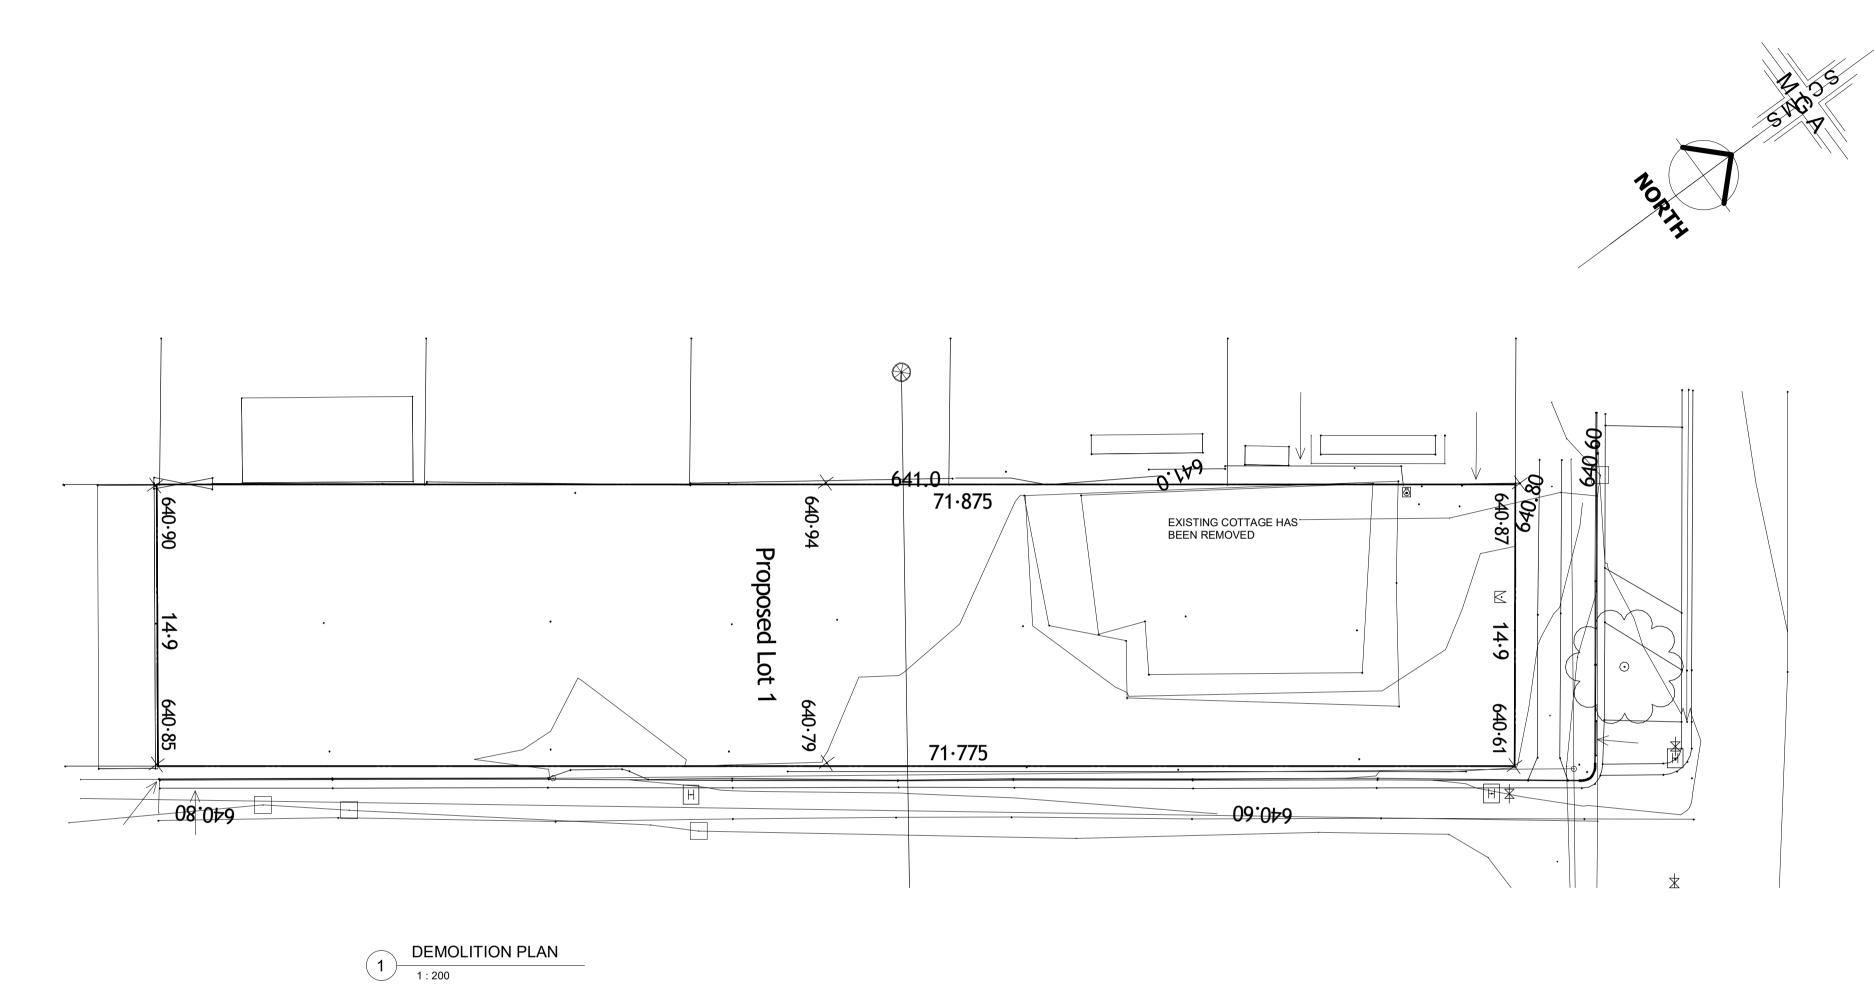
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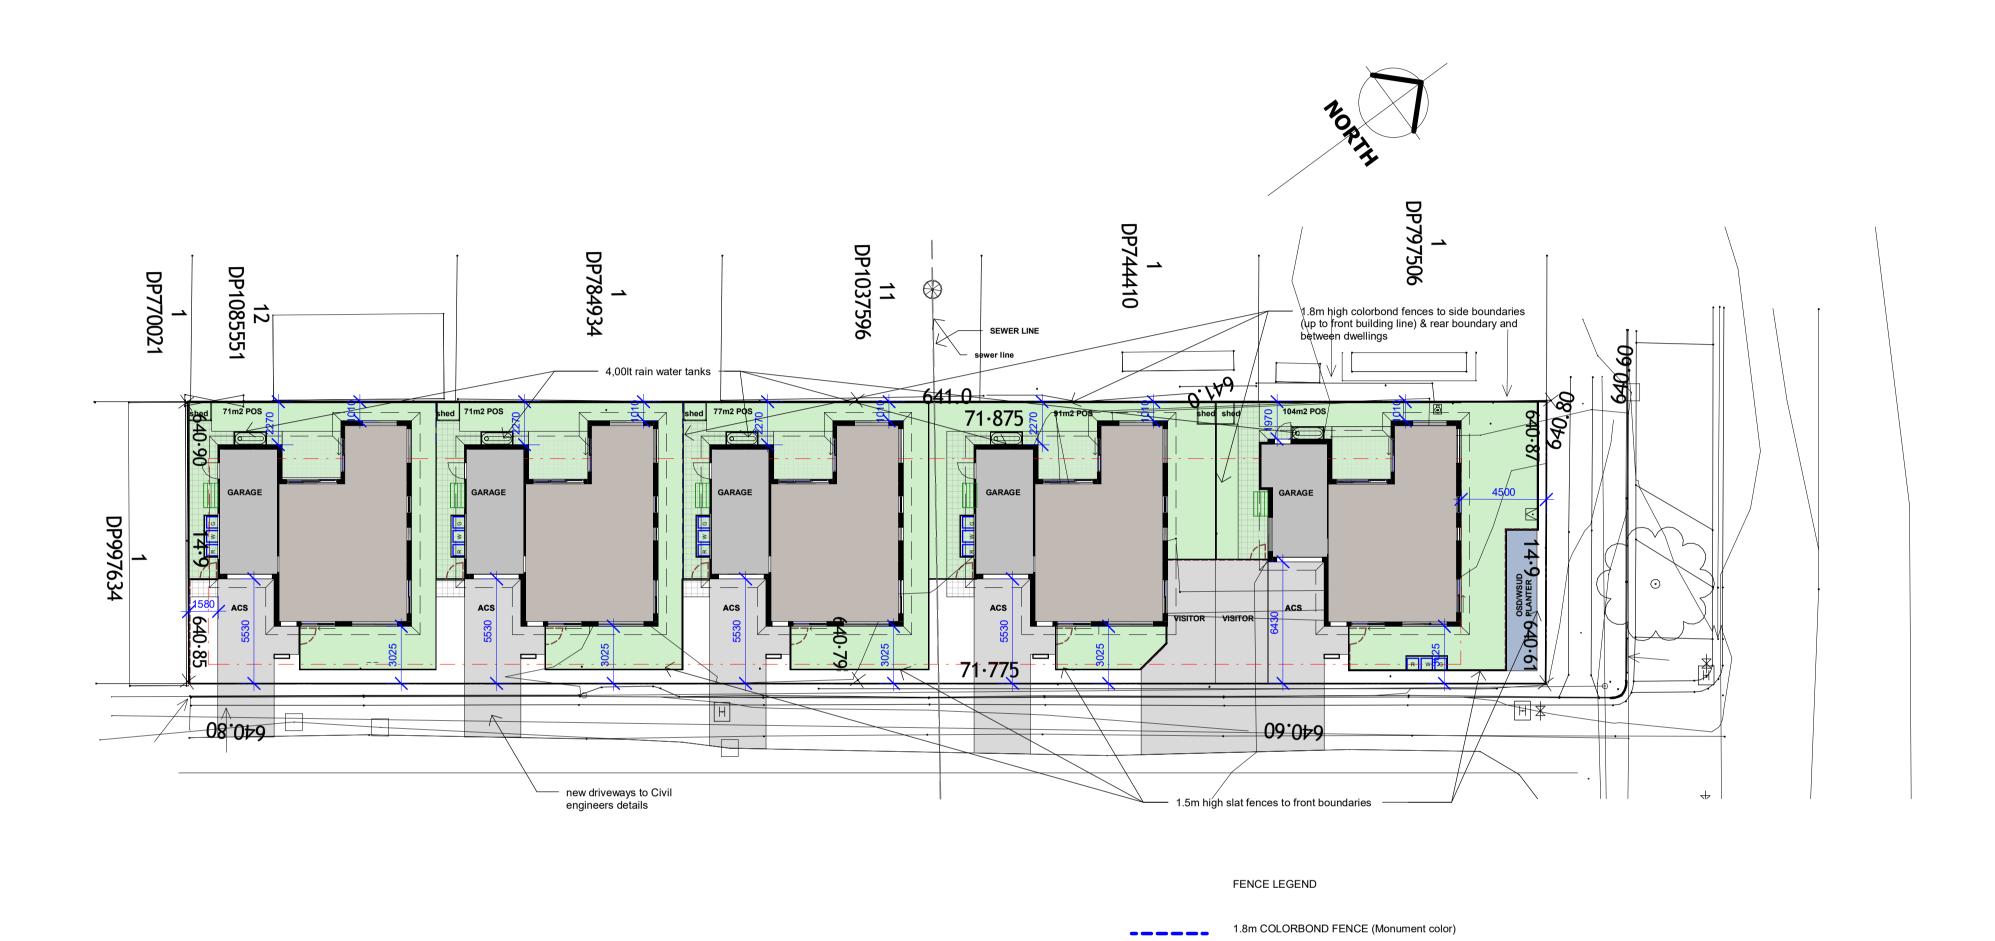
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1.5m SLAT FENCE (Monument color)

SITE PLAN

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PROJECT: MULTI UNIT DEVELOPMENT

ISSUE: DEVELOPMENT APPLICATION

DRAWING
TITLE: SITE PLAN

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DATE: SEPT. '24

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PR. NO: LITHGOW ST

DWG NO: DA04.1

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Trident Maple Japanese Maple

PLANT SCHEDULE

Shrubs and Groundcovers Pjs Pittosporum 'James Stirling' Pittosporum

Landscape work to be in accordance to canberra landscape guidelines and the actpw basic specification for roads, hydraulics and landscape 1991, incl corringenda 1+2. In particular, note: Make good any damage to disturbed areas and include all obvious work.

Strip and stockpile any top soil as directed by the superintendent.

The contractor shall confirm the locations of all services with the relevant authorities prior to earthworks and planting. Planter bed mounds to consist of excess fill cultivated with topsoil and fertilizer as recommended by the plant supplier and topped with euci mulch to 50mm min. depth.


Remaining areas to be mulched garden beds UNO

Topsoiling garden areas: spread stockpiled site topsoil with 30% aged cow manure thoroughly mixed prior to spreading to 300mm depth until supplies are exhausted, then supply and spread type 's' topsoil as required so that all garden beds have 300mm depth topsoil, then incorporate into cultivated subsoil. Rake over to remove any viable organic matter or stones / clods greater than 50mm diameter.

Planting: supply and plant as per schedule. Fertilise all plants with 30gms low phosphorous 'osmocote' at time of planting. Excavate planting hole 100mm wider and deeper than pot size, set plant level in hole, and backfill with topsoil mix.

Stake all deciduous trees with two 1800x50x50mm hardwood stakes embedded 600mm, 300mm away from trurk. Where support is necessary, tie trurk to stake with 2 no. 50mm wide hessian tes, five also law for ground as possible.

Mulching: supply and place 75mm 'coarse forest litter' mulch to all garden areas. Form 1000mm dia mulched watering basins to all trees in dry grass. Verge Dryland Grassing: cultivate, topsoil, prepare for and sow dryland grass mix 'type c' spread bitument / straw mulch, and fertilise Consolidation period to be 13 weeks.

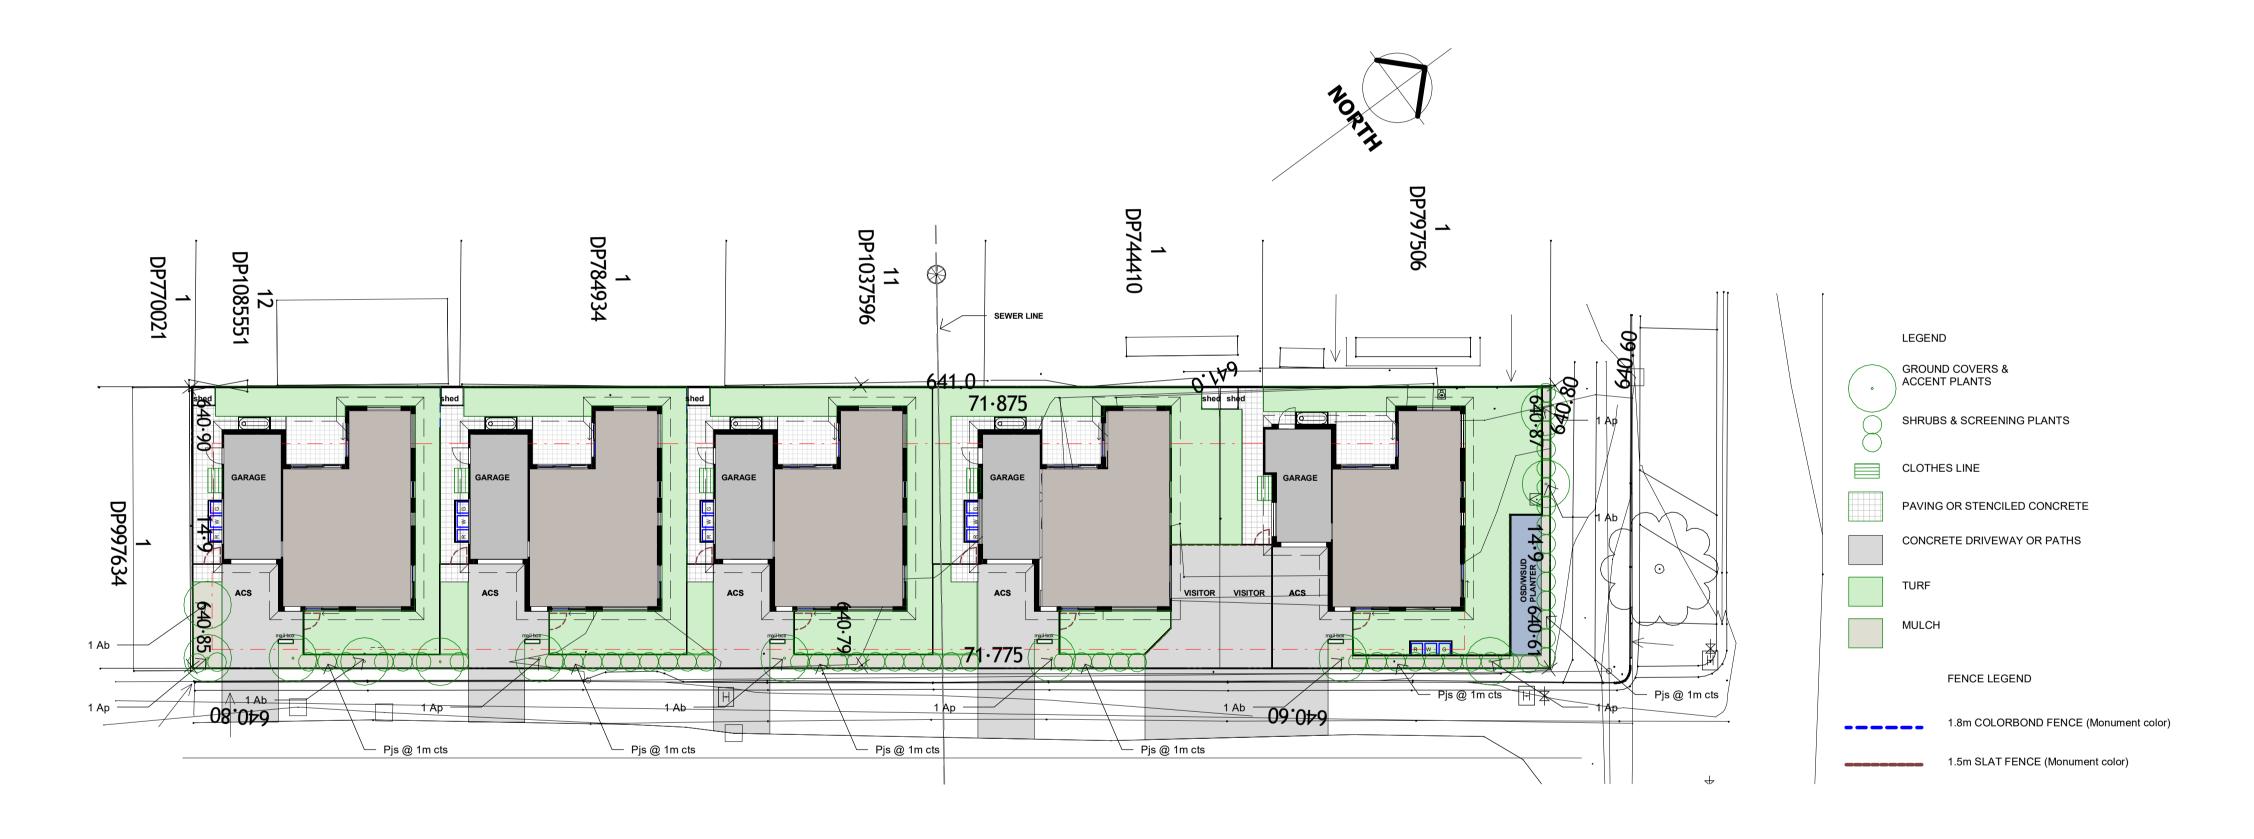





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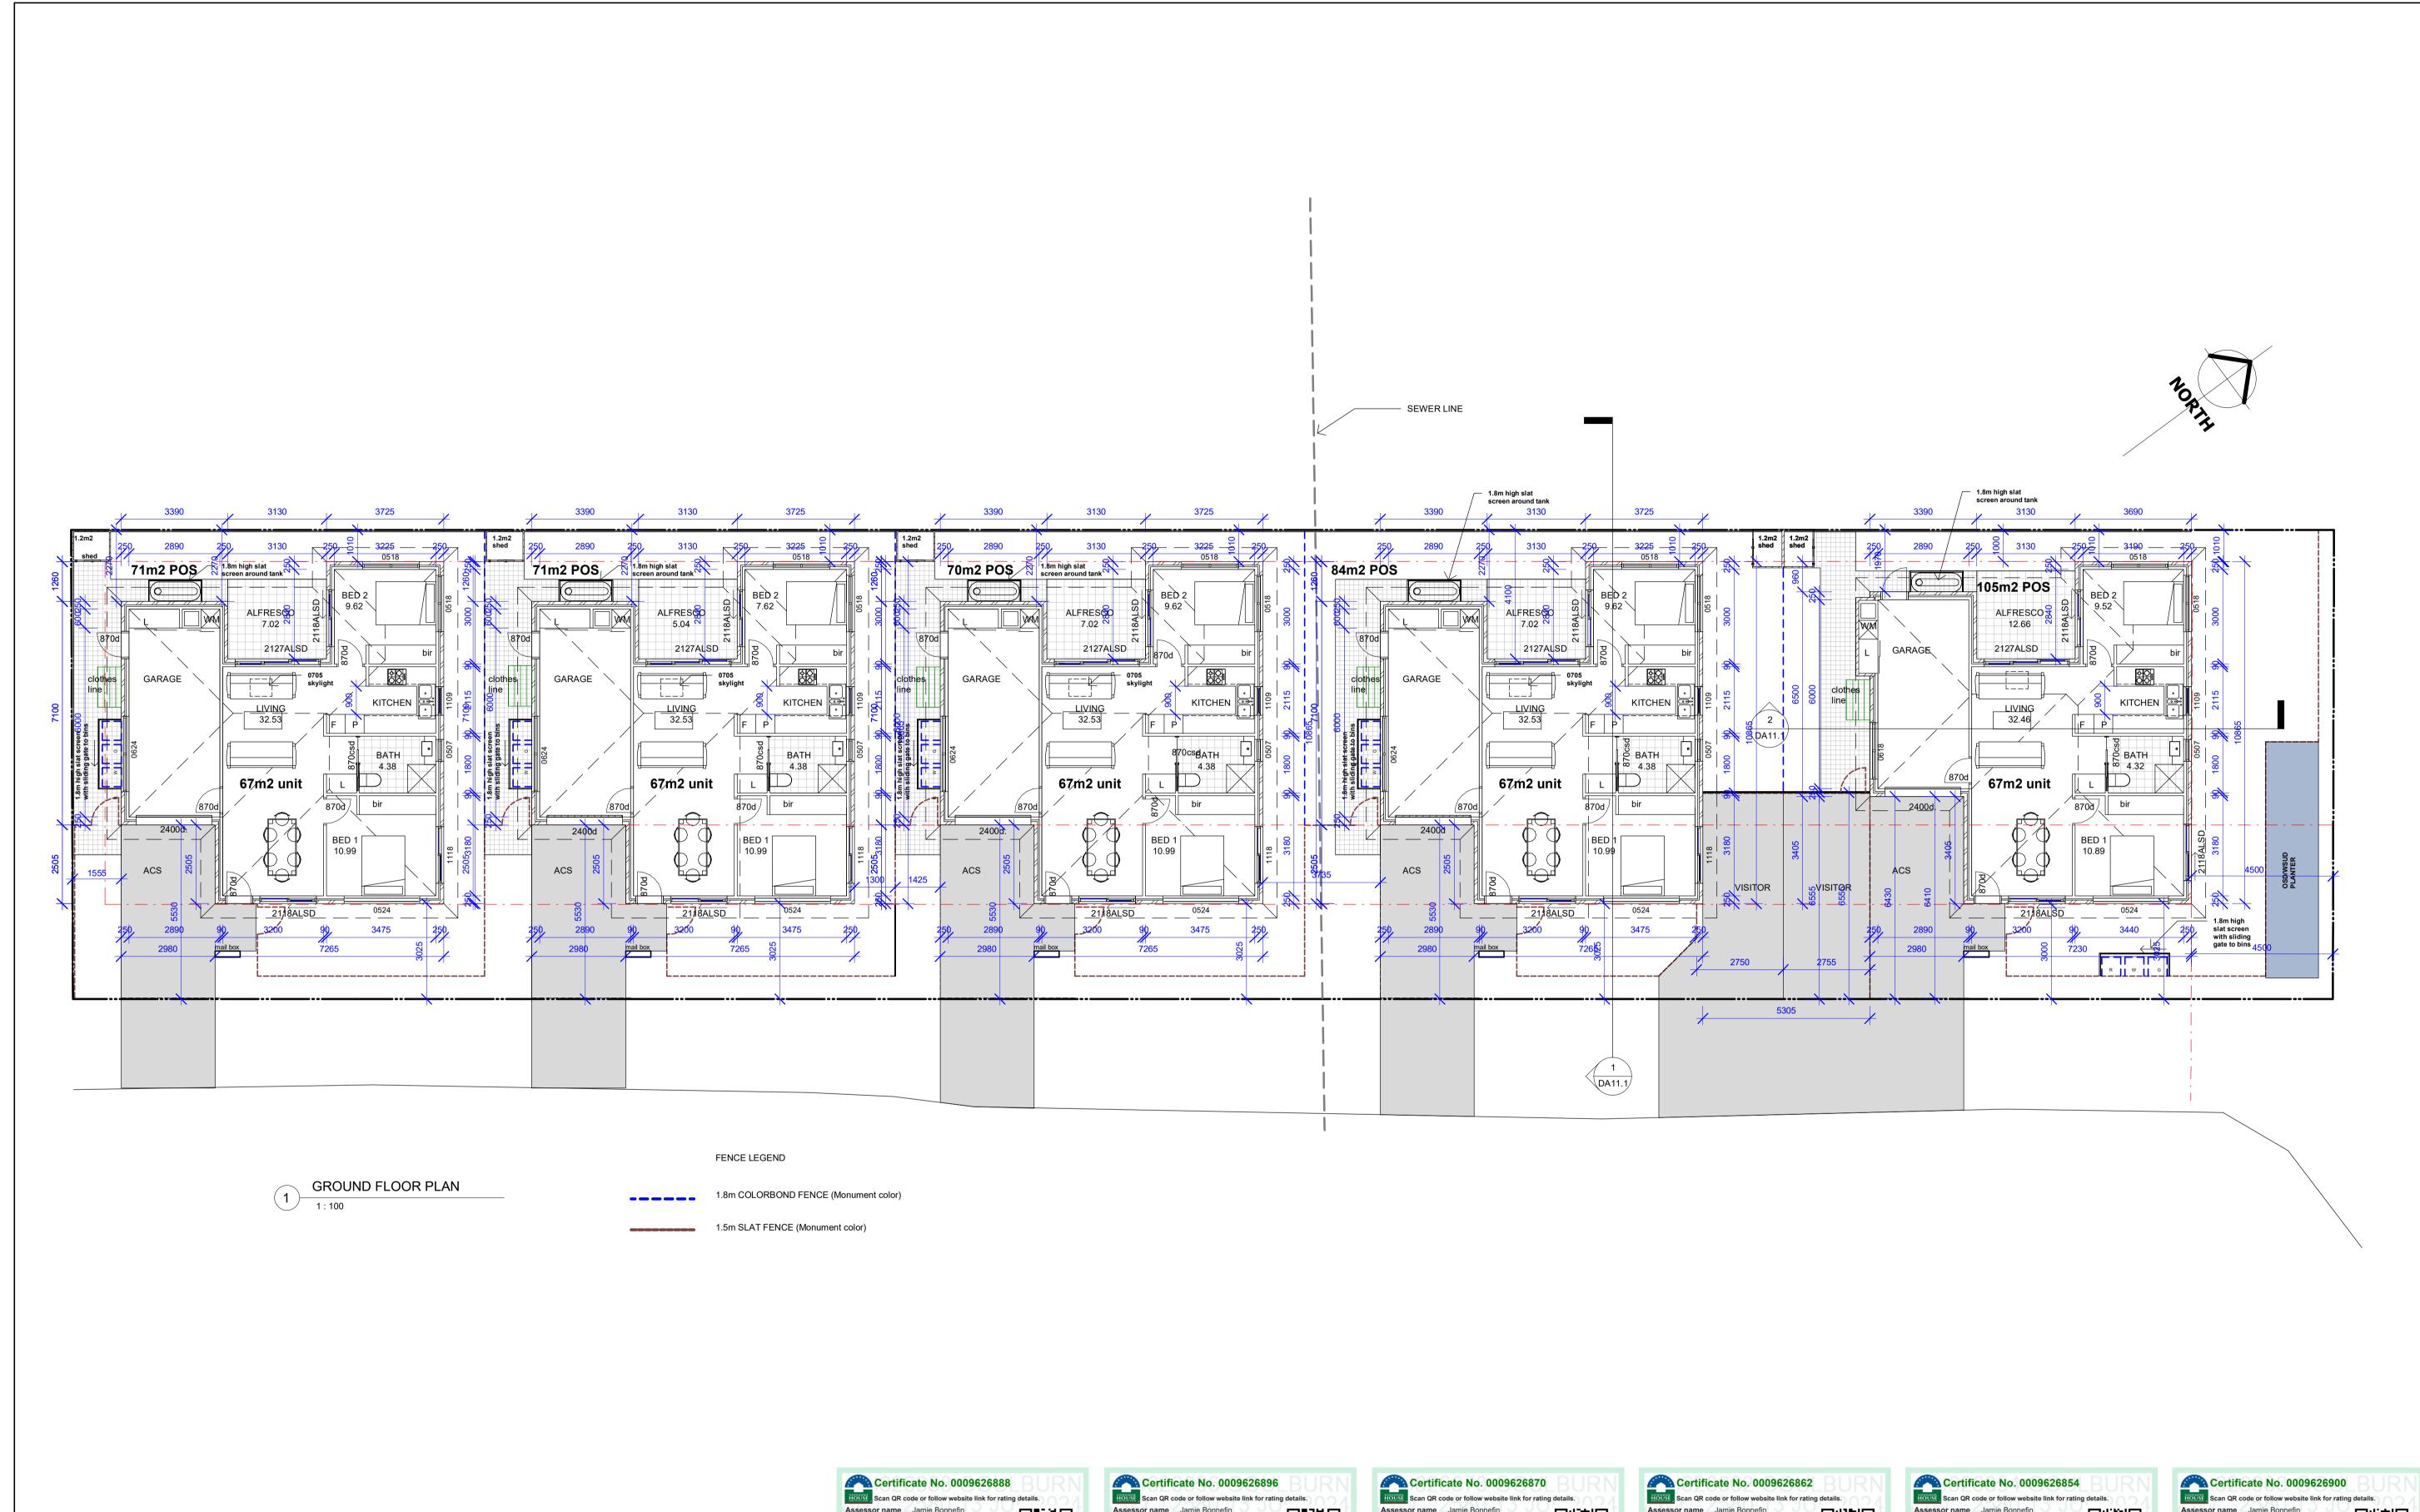
MULTI UNIT DEVELOPMENT PROJECT: ISSUE: DEVELOPMENT APPLICATION DRAWING TITLE: LANDSCAPE PLAN

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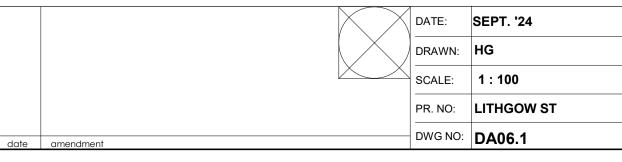




PROJECT:	MULTI UNIT DEVE	LOPMENT			
ISSUE:	DEVELOPMENT A	PPLICATION			
DRAWING TITLE:	GROUND FLOOR	PLAN			
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(Monument)

rendered walls painted

off-white (Surfmist)

— Grey face brick walls

NORTH WEST ELEVATION

1:100




(Monument)


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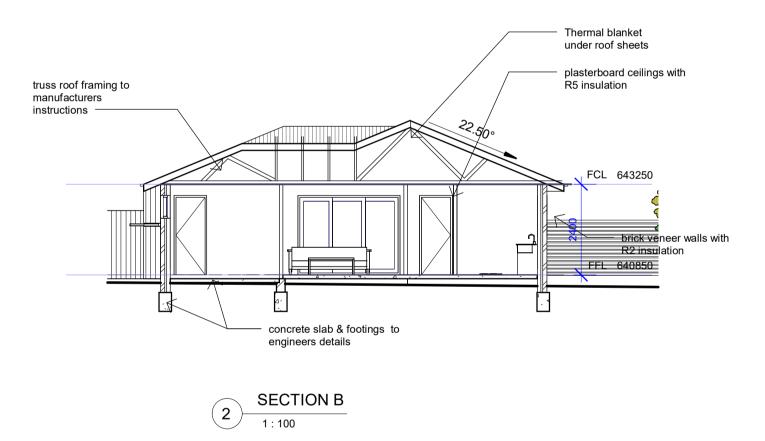
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Street, GOULBURN

Assessor name Jamie Bonnefin Accreditation No. 10056 Property Address 26 Lithgow





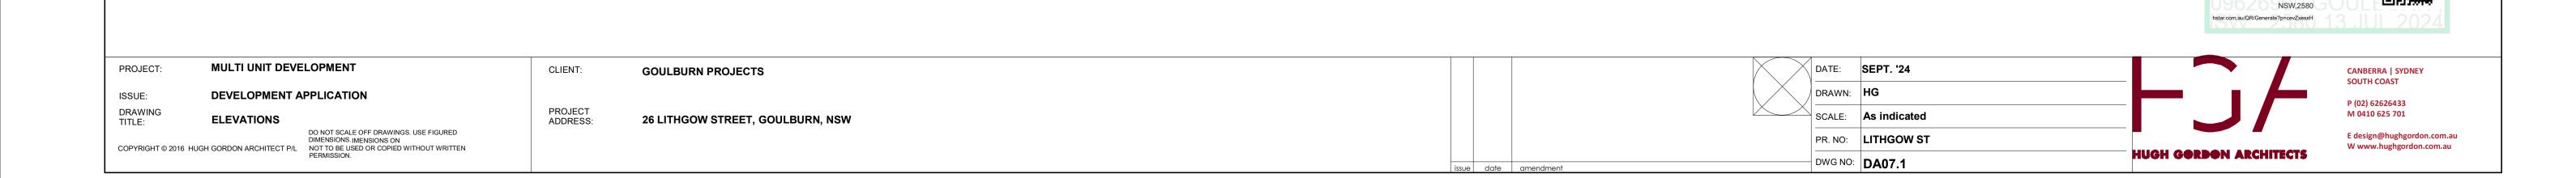

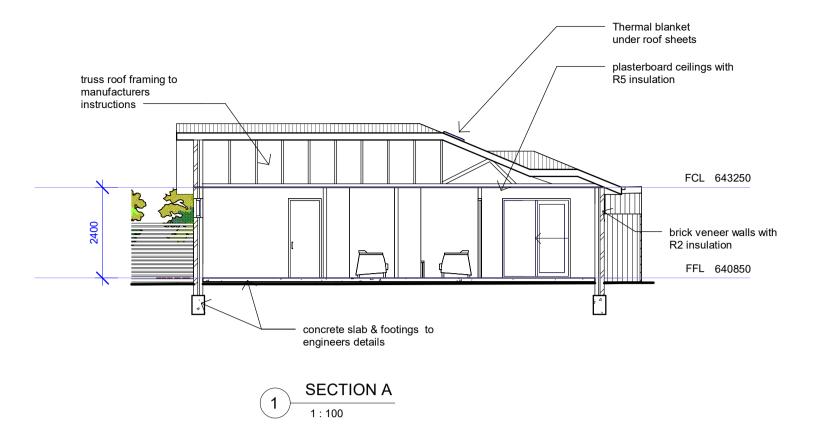NOTES & GENERAL CONDITIONS

FEES REQUIRED BY THE AUTHORITIES.

ALL CONSTRUCTION IN ACCORDANCE WITH BCA AND RELEVANT SAA CODES

COMPLETE THE WORKS WITHIN THE CONTRACT PERIOD IN ACCORDANCE WITH THE DRAWINGS.

COMPLY WITH REGULATIONS AND BY-LAWS OF AUTHORITIES WITH JURISDICTION OVER THE WORKS AND INCLUDING THOSE RELATING TO WATER SUPPLY, GAS, SEWERAGE, HEALTH AND ELECTRICITY. GIVE ALL NOTICES AND PAY ALL

WORK SHOWN OR DESCRIBED ON THE DRAWINGS OR IN THE SCHEDULE IS TO BE CARRIED OUT WHETHER DRAWN AND NOT SPECIFIED OR VICE VERSA. THE REQUIREMENTS OF REGULATIONS TAKE PRECEDENCE OVER THE DRAWINGS. DETAIL DRAWINGS TAKE PRECEDENCE OVER GENERAL DRAWINGS.

SHOP DRAWINGS OR FABRICATING COMPONENTS. REPORT ANY DISCREPANCIES TO ARCHITECT FOR DECISION BEFORE PROCEEDING WITH WORK.

BUILDER TO VERIFY ALL DIMENSIONS ON SITE PRIOR TO COMMENCEMENT OF CONSTRUCTION WORKS, PRODUCING

WRITTEN DIMENSIONS ARE IN MILLIMETERS AND TAKE PRECEDENCE OVER SCALED ONES BUILDER TO CHECK WINDOW DIMENSIONS BEFORE

ORDERING GROUND LINES SHOWN ARE INDICATIVE ONLY AND SHOULD

BE VERIFIED ON SITE

LINTELS TO TRUSS MANUFACTURERS TABLES, NEW TIMBER ROOF TRUSSES TO MANUFACTURER'S SPECIFICATION.

CONCRETE SLABS AND FOOTINGS TO AS. 2870-1998 ENGINEERING OPTION ADOPTED. ALL FOOTINGS TO BE TAKEN DOWN TO SOLID GROUND, TERMITE PROTECTION TO COMPLY WITH AS.1694 'PHYSICAL BARRIERS' & AS. 3660 'APPENDIX D' AND TO ACT BUILDING CONTROL BUILDING NOTE NO.3, FRAMING TO AS. 1684-1992 'NATIONAL TIMBER FRAMING CODE' AND SUPPLEMENTS. HARDWOOD TO AS.3000, BRICKWORK TO AS.3700 'SAA MASONRY CODE AND AS.1640 'SAA BRICKWORK CODE', STRUCTURAL STEEL TO AS.1170 & AS.4100, SMOKE ALARMS TO AS.3786, WET SEAL TO AS.3740, PLUMBING TO AS3500.

STEEL FRAMED DOORS & WINDOWS TO AUSTRALIAN USE STANDARD SIZED DOORS WHERE POSSIBLE

ENGINEERING DOCUMENTATION TAKES PRECEDENCE OVER ARCHITECTURAL STRUCTURAL SIZINGS.

GRADE SITES TO ALLOW FOR SURFACE DRAINAGE

SMOKE ALARMS CONNECTED TO MAINS POWER SUPPLY, WITH BATTERY BACKUP, ARE TO BE INSTALLED IN ACCORDANCE WITH AS 3786-1993

Commitments Table

	is is	Proposed: Multi Dwelling Lot Number: 1		actification of the NCM 2500			
	Project Details	Proposed: Multi Dwelling		Address: 26 Lithgow Street, Goulburn NSW 2580 DP NUMBER: 1302794			
ı	ھ ک	Lot Number: 1		DP NUMBER: 1302794			
r				BASIX Certificate Number: 1756731M_02			
		Fixtures		Specification			
		Shower head rating Toilet rating		3 star (> 6 but <= 7.5 L/min) 3 star			
ı		Kitchen taps rating		3 star			
ı	te	Bathroom taps rating		3 star			
ı	Water	Alternative water details					
ı	>	Rainwater tank size	Individual	2000L			
ı		Connected to: Garden and lawn areas		Yes			
ı		All toilets Laundry		Yes Yes			
ı		Accreditation Number: External walls	HERA 10056	NatHERS Certificate Number: 0009626900 Requirements			
ı		Brick veneer		Medium colour R2.7 Bulk + Anti-glare foil			
ı		Internal conflic					
ı		Internal walls					
ı		Cavity wall, direct fix plasterboard	Around garage and bath	R2.7 Bulk insulation			
ı		Cavity wall, direct fix plasterboard		No insulation			
ı		Ceiling					
ı		External ceiling - Plasterboard		R5.0 Bulk insulation			
ı		Roof					
ı				Dark Colour (solar absorptance >0.70)			
ı		Corrugated iron		R1.8 Bulk + Reflective side down, No air gap above (Anticon 75, 80mm)			
ı		Floors					
ı		Concrete slab on ground		R1.5 XPS (Extruded Polystyrene)			
ı	ť	Concrete slab on ground	Garage	No insulation			
ı	fort	Windows	(NSW BASIX T	Thermal Protocol allows for ± 10% tolerance of SHGC Value & U Value =< than which overrides NatHERS Certificate)			
ı	Com	Aluminium frame ALM-002-01	Garage and Bath	Single Clear glazing with U-value 6.7 and SHGC 0.7 for Group B windows (double hung, fixed, louvres and sliding type windows/doors)			
ı		Additional Paris ALM 602 01	Garage and Bath				
ı	Thermal	Aluminium frame ALM-004-03		Double air-fill low-e glazing with U-value 4.3 and SHGC 0.53 for Group B windows (double hung, fixed, louvres and sliding type windows/doors)			
ı	err	Aluminium frame ALM-006-03	Dwelling 1 and 2	Double argon-fill low-e glazing with U-value 4.1 and SHGC 0.52 for Group B windows (double hung, fixed, louvres and sliding type			
ı	Ĕ	, na	Dwelling 1 and 2	windows/doors)			
ı		Skylights					
ı		Double Glazed Skylight					
ı		Ceiling Penetrations					
ı		Downlight Covers		Approved fireproof downlight covers must be installed to all downlights in ceilings where insulation is installed.			
ı							
ı		Lighting specification		Dwelling is rated with Assumed downlight as per NatHERS Tech Note "Ceiling Penetrations 9.4 to 9.8"			
ı		Ceiling fans		No ceiling fans need to be installed			
ı		Overshadowing details		Adjoining units calculated into model calculations			
ı				,			
' 		Site Orientation of nominal north elevation		As shown on plans			
ı				AS SHOWN ON Plans			
ı		* Approved fireproof downlight covers HAVE bathrooms, ensuites and internal laundry's)		ly covered by insulation. Ceiling penetrations for exhaust dampers have been allowed (to all			
ı		batillooms, ensures and internal laundry sy	at the rate of 0.04 meters square	eu per exhaust fan penetration.			
ı		Hot water		Specification Rating			
ı		Individual system		Gas instantaneous 7 star			
ı		Ventilation					
ı		Bathroom exhaust		Individual fan, not ducted			
ı		Control switch		Manual switch on/off			
ı		Kitchen exhaust		Individual fan, not ducted			
ı		Control switch		Manual switch on/off			
ı		Laundry		Individual fan, not ducted			
ı		Control switch		Manual switch on/off			
ı		Cooling					
ı		Individual systems - living areas		1-phase airconditioning EER > 4.0			
ı	Energy	Individual systems - bedroom areas		1-phase airconditioning EER > 4.0			
ı	ne						
ı	ш	Heating					
ı		Individual systems - living areas		1-phase airconditioning EER > 4.0 1-phase airconditioning EER > 4.0			
ı		Individual systems - bedroom areas		1-phase air conditioning EER > 4.0			
ı		Lighting					
		Refer to NatHERS Certificate		Light-emitting diode (LED)			
		Appliances		Cos coalitan 9 alactria que			
		Cooktop/oven Private outdoor clothes drying line		Gas cooktop & electric oven			
		Private outdoor clothes drying line Private Indoor or sheltered clothes drying line	2	Yes No			
		The state of the s					
		Alternative Energy		Peak kW			
		Photovoltaic System (Minimum)		N/A			



MULTI UNIT DEVELOPMENT PROJECT:

DEVELOPMENT APPLICATION

DRAWING TITLE:

ISSUE:

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Accreditation No. 10056

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PROJECT: MULTI UNIT DEVELOPMENT

ISSUE: **DEVELOPMENT APPLICATION**DRAWING

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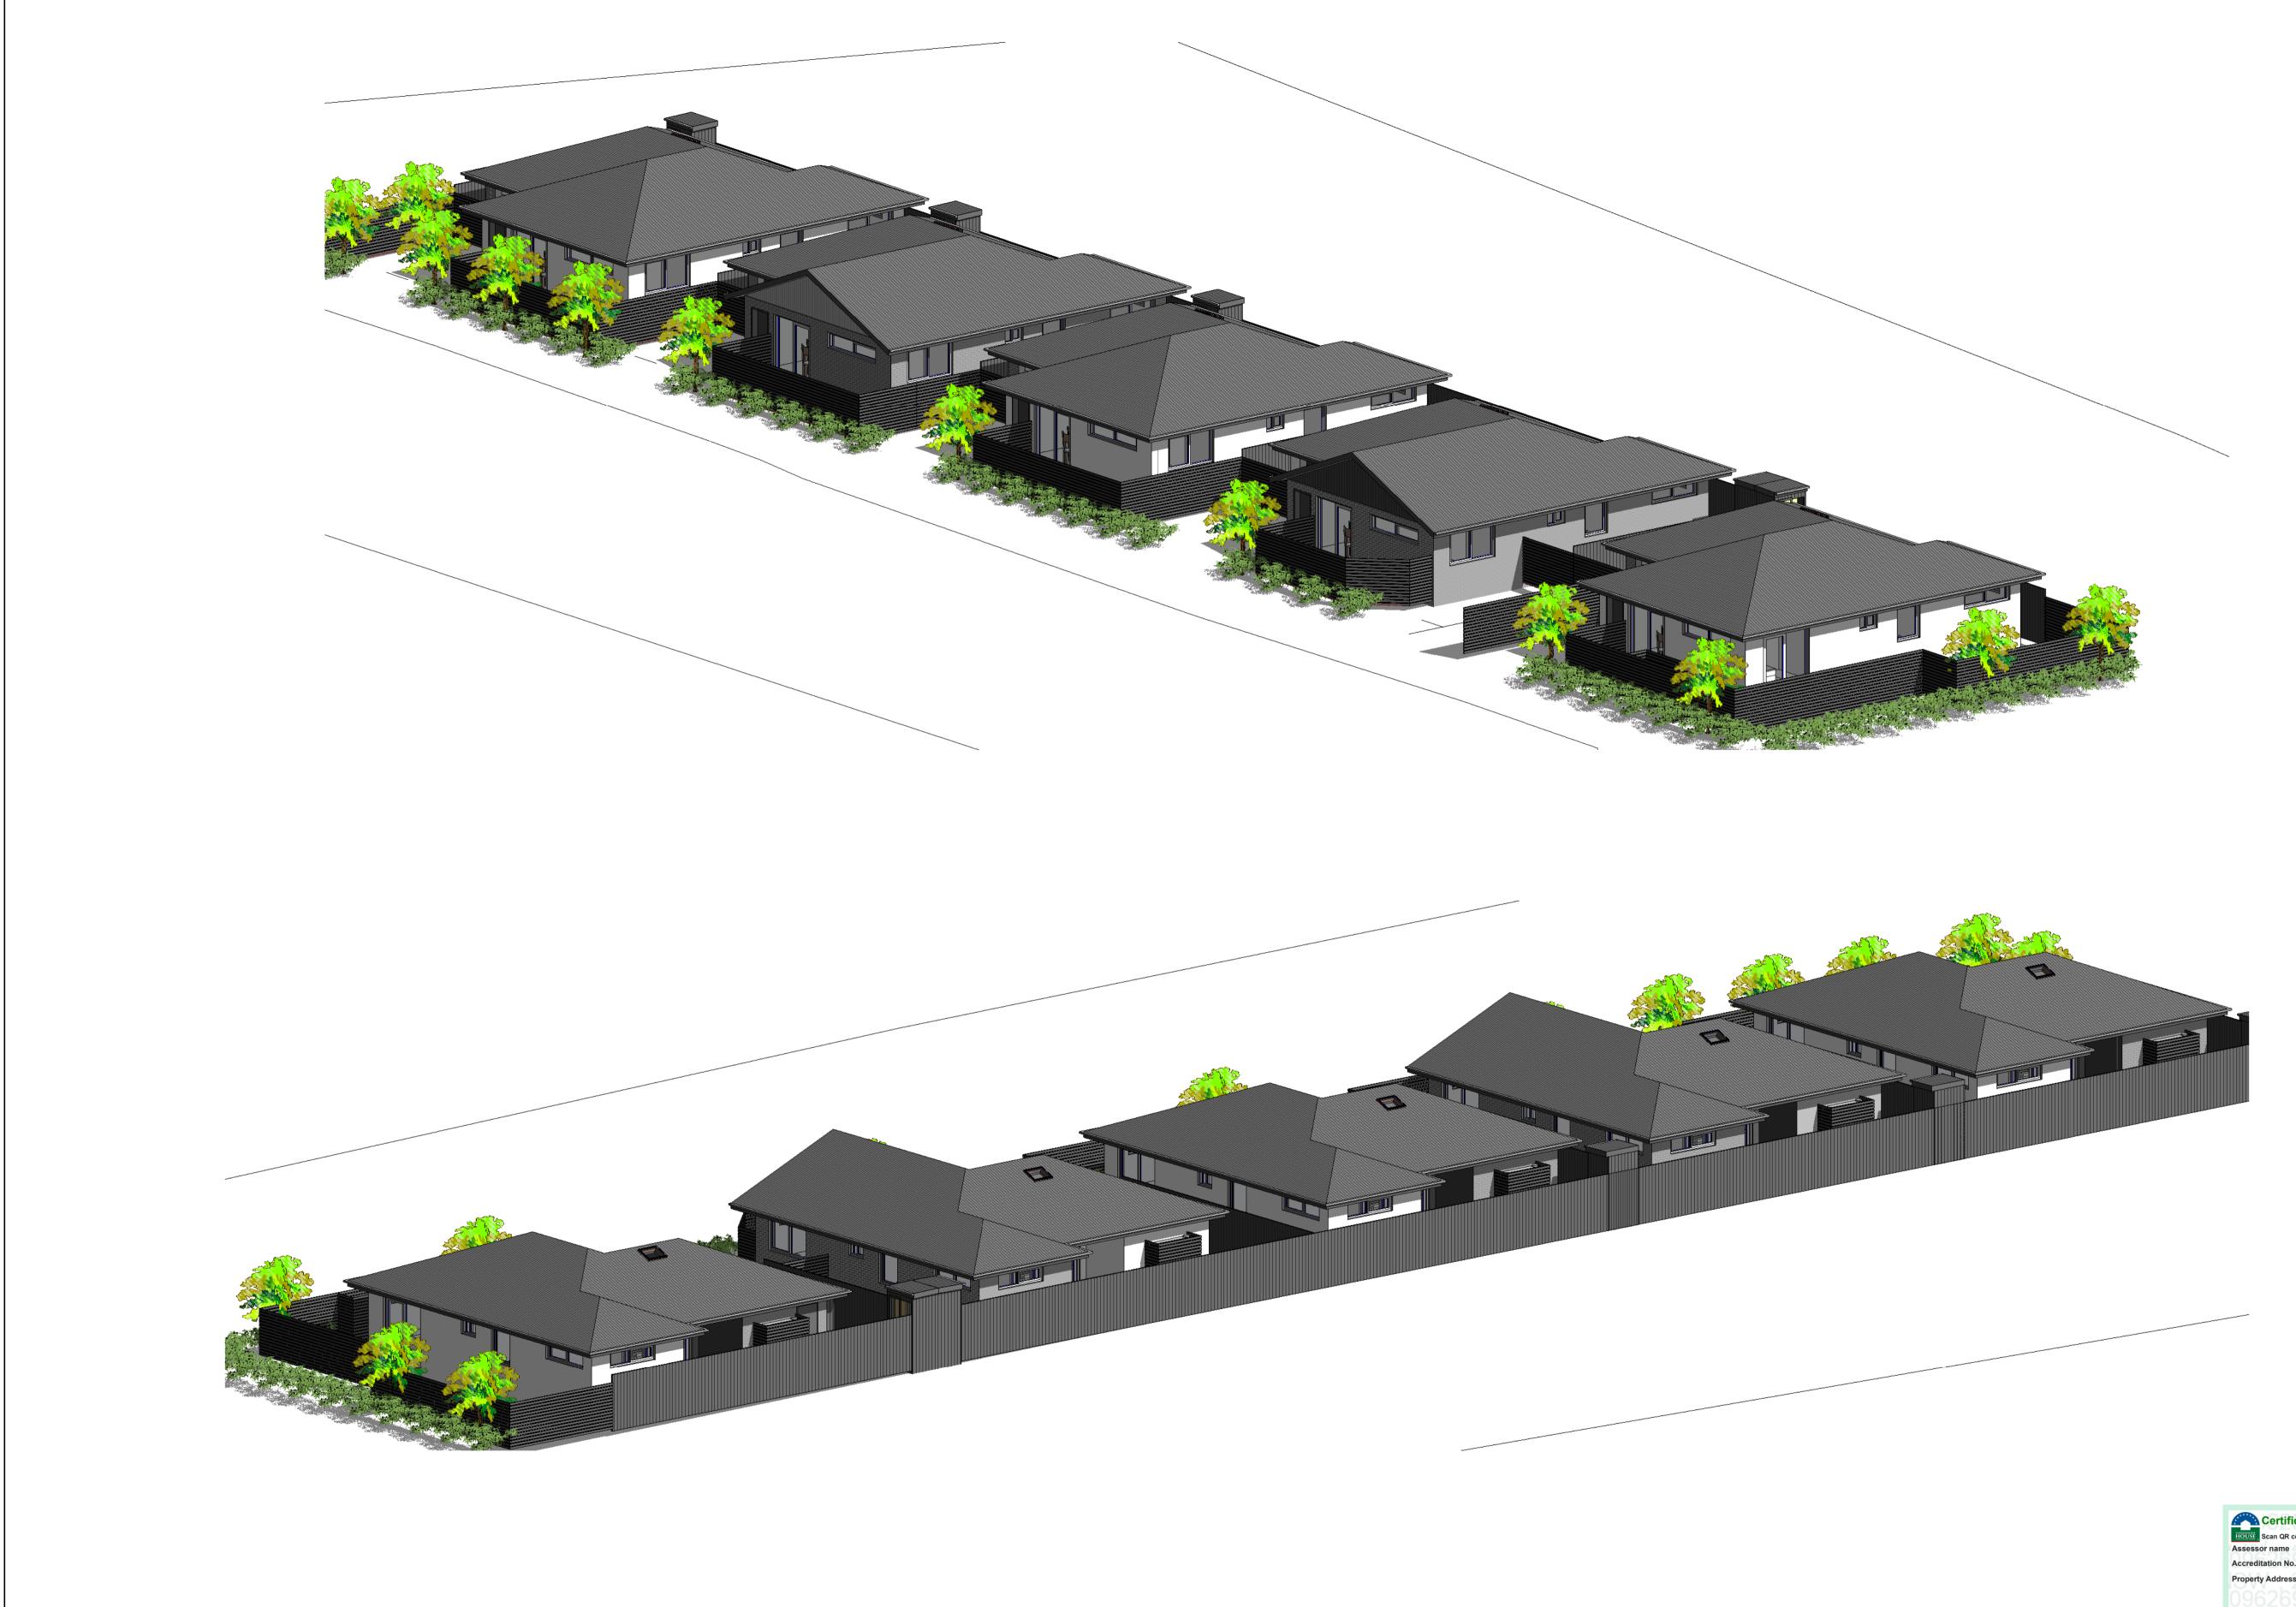
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PROJECT: MULTI UNIT DEVELOPMENT

ISSUE: DEVELOPMENT APPLICATION

DRAWING TITLE: ISO VIEWS

TITLE:

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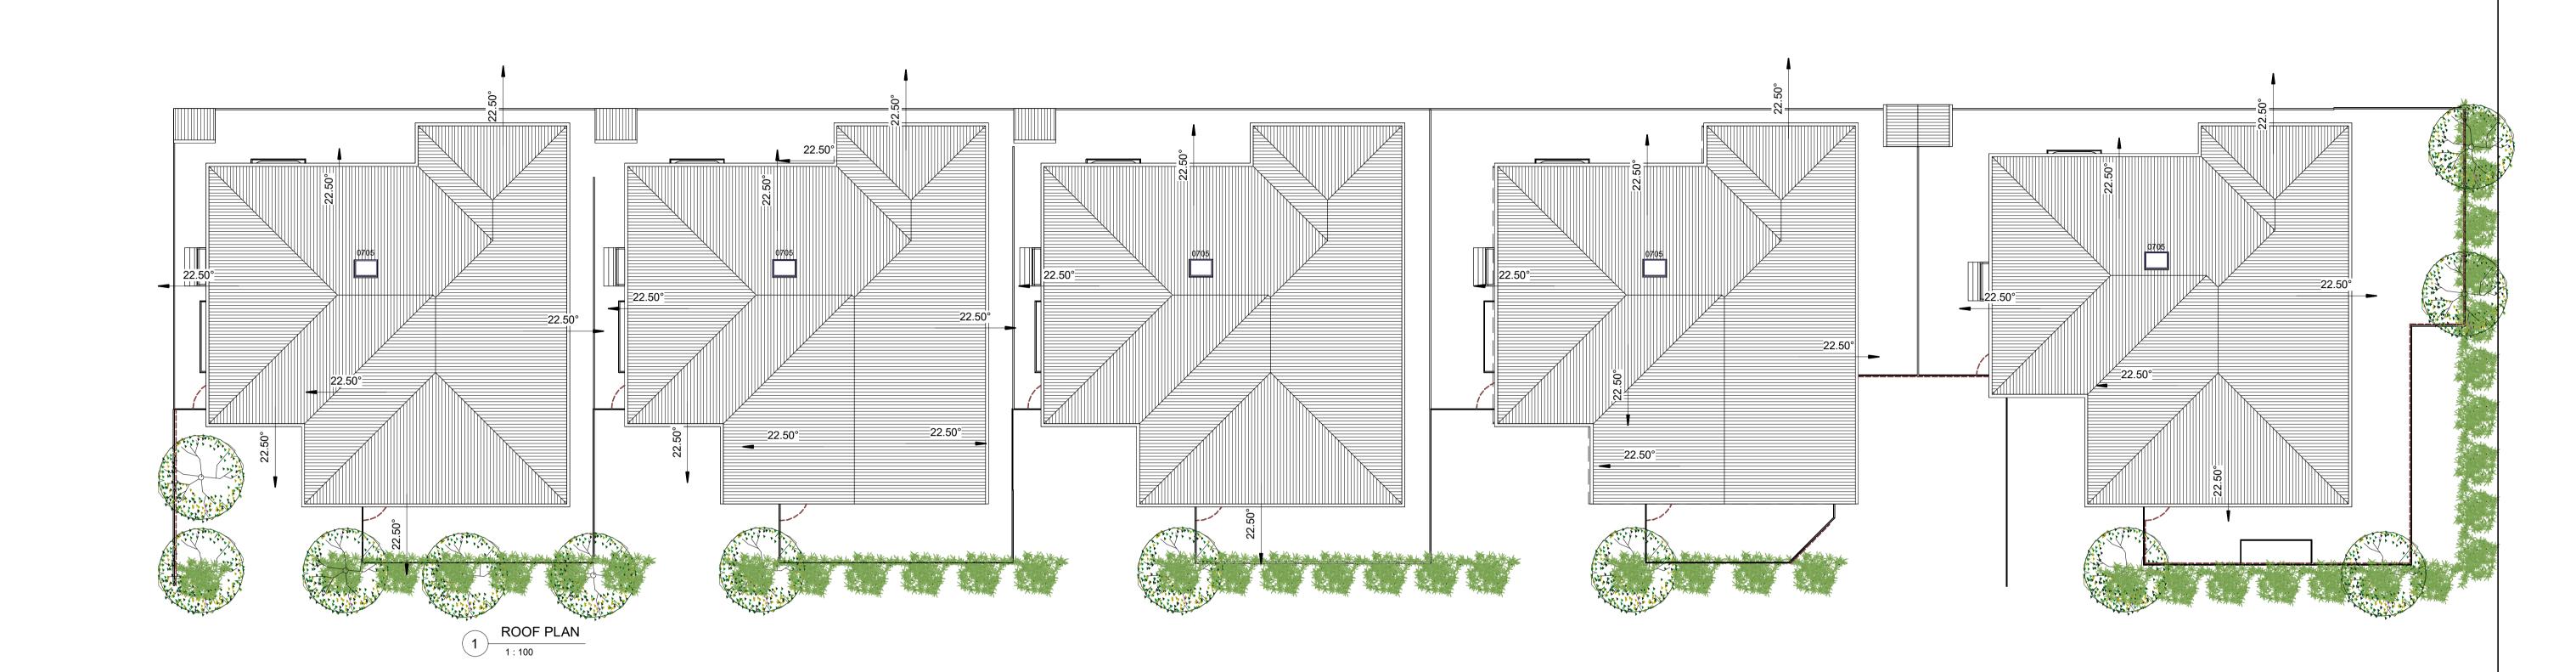
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PROJECT: MULTI UNIT DEVELOPMENT

ISSUE: DEVELOPMENT APPLICATION

DRAWING
TITLE: ROOF PLAN

DRAWING
TITLE:

ROOF PLAN

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DATE: SEPT. '24

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PR. NO: LITHGOW ST

DWG NO: DA16.1

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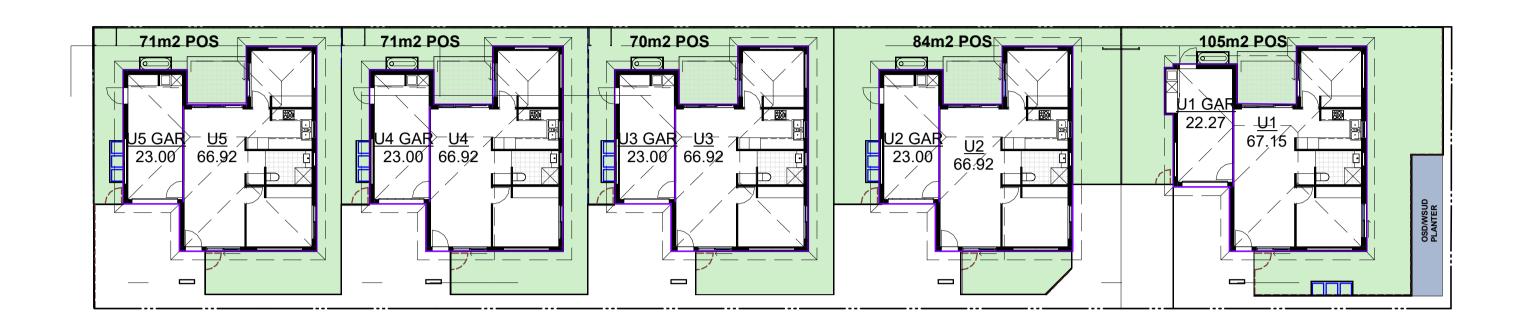
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SITE AREA = 1070m2

Name	Area
114	107.45
U1	67.15
U1 GAR	22.27
U2	66.92
U2 GAR	23.00
U3	66.92
U3 GAR	23.00
U4	66.92
U4 GAR	23.00
U5	66.92
U5 GAR	23.00
Grand total: 10	449.12



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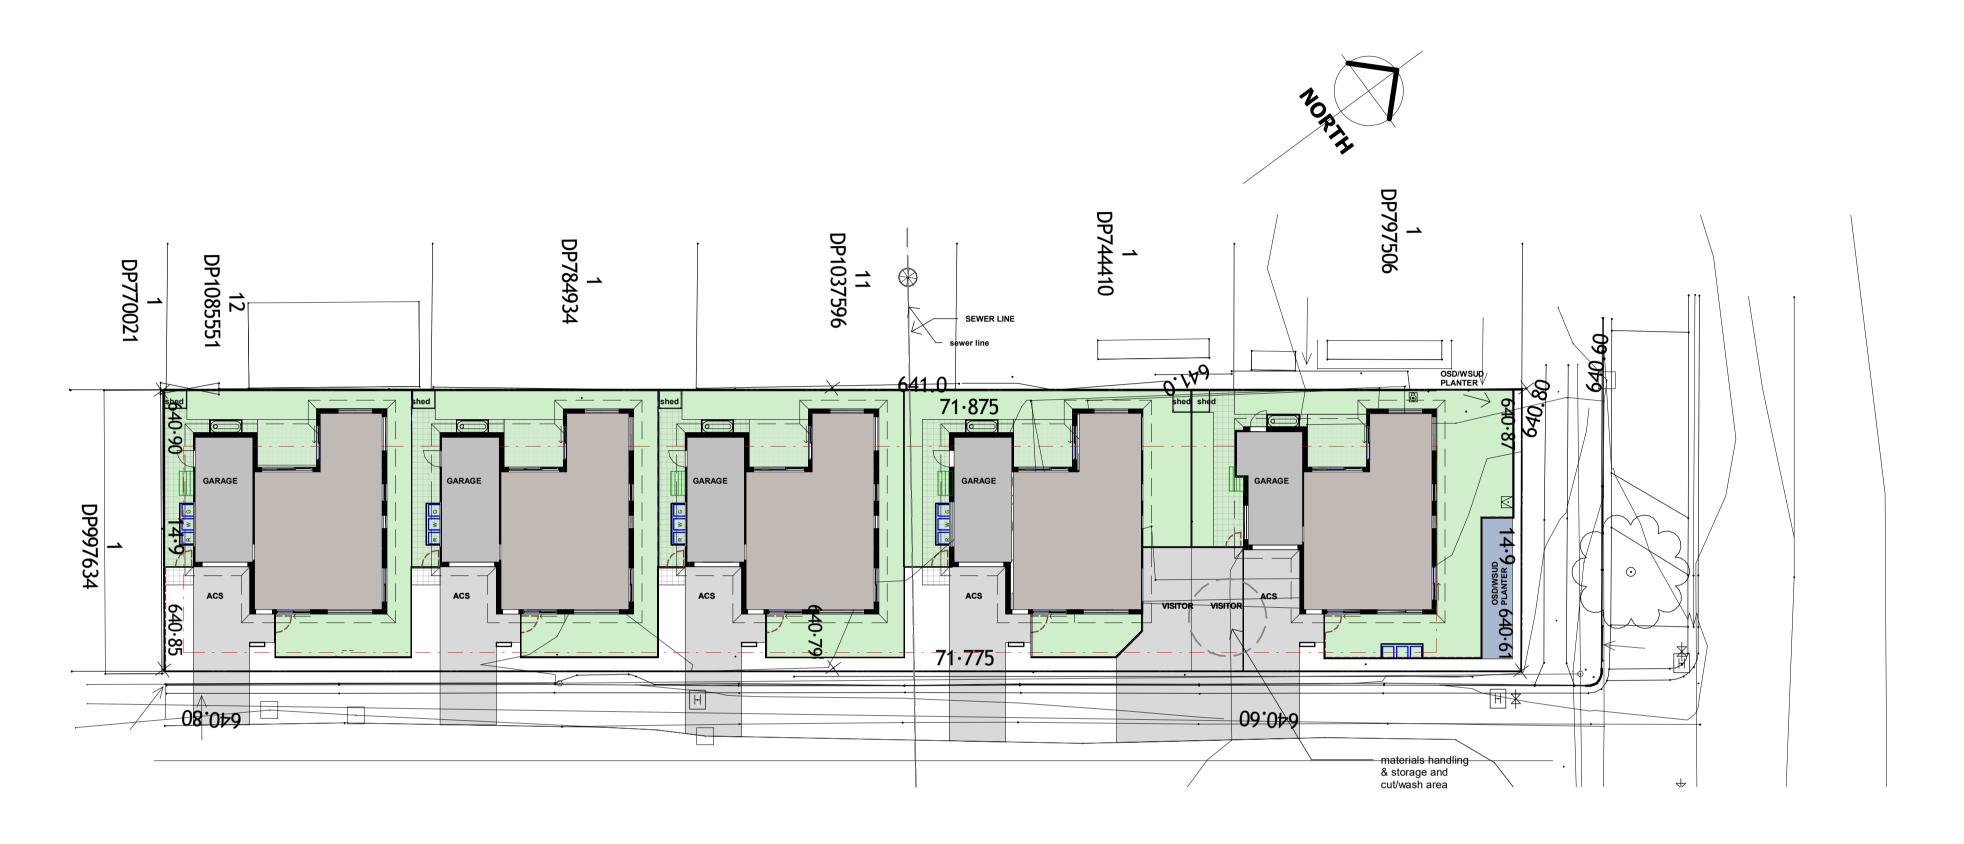
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ISSUE: DRAWING TITLE:	DEVELOPMENT APPLICATION AREA PLANS	PROJECT	26 LITHGOW STREET, GOULBURN, NSW			DRAWN SCALE:	HG 1:200		P (02) 62626433 M 0410 625 701
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	PERMISSION.			issue date	amendment	DWG NO	DA17.1	HUGH GORDON ARCHITECTS	



SEDIMENT & EROSION CONTROL PLAN

1:200

SEDIMENT CONTROL NOTES

- Provide Sediment and erosion controlbarriers as shown.

 Stock pile/s to be located away from drainage lines and surface flow paths, contoured striations or furrows to be provided to stock piles to
- minimize erosion.
- Stabilised construction entrance to be constructed prior to access to site by construction vehicles. Aggregate to be turned when sediment builds up. Where storm water drainage is installed to internal roadwork's, provide grated sump filter in accordance with given detail.

 Average existing site slope is: Less than 5% sediment control barrier not required.
- not required Total site area is : 1070 m²
- Builder is to establish a maintenance program for sediment & Erosion control devices to ensure inspection after significant rainfall and that any
- repairs necessary are quickly attended to.

 Environment protection agreement to be taken out by building contractor with Environment Protection Authority.

 All new construction work must be contained within the site except for approved service connections and roadwork's or noted explicitly on decumentation. documentation.
- Limit access to site during and immediately after wet weather.
 Regularly remove any soil from roads adjacent to the site.
- No storage or construction materials, parking of vehicles nor equipment permitted outside of blocks without Authority approval.
- No site sheds, storage sheds, site amenities to be erected outside of blocks without Authority approval.
- Provide kerbside filter roll to existing sumps.

 Kerbside filter rolls to be removed, cleaned and reinstated on a weekly
- basis at a minimum. Trapped sediment about sumps also to be removed, cleaning is also to take place immediately after periods of rainfall during
- All service trenches to be back filled within 24 hours of inspection. Excess soil is to be disposed at an approved location.



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SEDIMENT & EROSION CONTROL PLAN DO NOT SCALE OFF DRAWINGS. USE FIGURED DIMENSIONS. IMENSIONS ON NOT TO BE USED OR COPIED WITHOUT WRITTEN PERMISSION. CLIENT: **GOULBURN PROJECTS**

PROJECT 26 LITHGOW STREET, GOULBURN, NSW ADDRESS:

DATE: SEPT. '24 DRAWN: Author SCALE: 1:200 PR. NO: LITHGOW ST DWG NO: **DA19.1**

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